

WASHINGTON UTILITIES AND TRANSPORTATION COMMISSION

City of Mount Vernon

Petitioner,

vs.

BNSF Railway Company
Respondent

DOCKET NO. TR-

PETITION TO MODIFY WARNING
DEVICES AT A HIGHWAY-
RAILROAD GRADE CROSSING

USDOT: **084758W**

Received
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State Of WASH.
UTIL. AND TRANSP.
COMMISSION

The Petitioner asks the Washington Utilities and Transportation Commission to approve modification of warning devices at a highway-rail grade crossing.

Section 1 – Petitioner’s Information

City of Mount Vernon
Petitioner

Signature

1024 Cleveland Avenue

Street Address

Mount Vernon, WA 98273

City, State and Zip Code

Mailing Address, if different than the street address

Esco Bell, Public Works Director

Contact Person Name & Signature

Phone: 360.336.6204 escob@mountvernonwa.gov

Contact Phone Number and Email Address

Section 2 – Respondent's Information

BNSF Railway Company

Respondent

2454 Occidental Ave S, Suite 2D

Street Address

Seattle, WA 98134

City, State and Zip Code

Mailing Address, if different than the street address

Stephen Semenick, Manager Public Projects – WA & B.C.

Contact Person Name

206.625.6152

Stephen.Semenick@BNSF.com

Contact Phone Number and Email Address

Section 3 – Crossing Location

1. Existing highway/roadway **4th St N / Riverside Dr**
2. Existing railroad **BNSF Railway Company**
3. USDOT Crossing No. **084758W**
4. GPS location **48.4302986 -122.3352959**
5. Railroad mile post (nearest tenth) **0068.829**
6. City **Mount Vernon** County **Skagit**

Section 4 – Vehicle Traffic

1. Name of highway 4th St N / Riverside Dr

2. Road authority City of Mount Vernon

3. Average annual daily traffic (AADT) 17,338

4. Number of lanes 5

5. Roadway speed 30 MPH

6. Is the crossing part of an established truck route? Yes X No _____

7. If so, trucks are what percent of total daily traffic? 5%

8. Is the crossing part of an established school bus route? Yes X No _____

9. If so, how many school buses travel over the crossing each day? 40

10. Describe any changes to the information in 1 through 7, above, expected within ten years:

AADT can be expected to increase 1% a year for the next ten years.

Section 5 – Current Crossing Information

1. Railroad company BNSF Railway Company

2. Type of railroad at crossing Common Carrier Logging Industrial

 Passenger Excursion

3. Type of tracks at crossing Main Line Siding or Spur

4. Number of tracks at crossing Two (2) total: (1) Main, (1) Siding

5. Average daily train traffic, freight 9

 Authorized freight train speed 50 MPH Operated freight train speed 50 MPH

6. Average daily train traffic, passenger 8

 Authorized passenger train speed 50 MPH Operated passenger train speed 50 MPH

7. Describe any changes to the information in 1 through 4, above, expected within ten years:

None known.

8. What is the available sight distance from the stop bar (or 25 feet from the tracks if no stop bar) on both approaches to the crossing?

Stopping Sight Distance: Stop NE to NE 200 feet, Stop NE to SW 350 feet, Stop SE to NE 500 feet, and Stop SW to SW 500 feet.

9. If the sight distance is less than 400 feet, describe the structures, roadway or track curvature, visual obstacles or other characteristics that limit sight distance.

Crossing Angle of 60 degrees and track curvature to the south.

Section 6 – Current Warning Devices

Provide a complete description of the warning devices currently located at the crossing (vehicle and pedestrian), including signs, gates, lights, train detection circuitry and any other warning devices.

(2) Crossbuck Assemblies

(1) W10-1 Advanced Warning Signs

(2) RR Xing Symbol Pavement Markings

(2) Cantilevered Flashing Lights

(2) Mast Mounted Flashing Lights

(2) Roadway Gate Arms

(1) Bell

Train Detection DC

Track Signaled

Section 7 – Description of Proposed Changes

Describe in detail the number and type of proposed automatic signals (vehicle and pedestrian), gates or other warning devices, including proposed circuitry. Please describe all other proposed changes at the crossing, including changes to the crossing surface, signage, pavement markings, etc. If sidewalks are being installed, please provide information on who will maintain them. (Attach additional information sheets, if needed.)

Two (2) New Automatic Pedestrian signals with gates behind the sidewalk. Constructed and maintained by BNSF.

One (1) new Automatic mast flasher signal. Constructed and maintained by BNSF.

One (1) New Pedestrian Warning Bell on Existing Cantilever. Constructed and maintained by BNSF.

Replace all existing warning signal lamps with LED type lights at existing cantilever, at (2) gate crossing arms, and gate masts. Constructed and maintained by BNSF.

Replace One (1) existing Bungalow with wayside horn interface panel. Constructed and maintained by BNSF.

Replace existing mainline and spur railroad crossing surfaces with new concrete panels with ADA compliant flangeways. Constructed and maintained by BNSF.

Remove existing utility pole obstructing a sidewalk, by BNSF. *SS 5/20/19*

Supplemental Wayside Horn Warning System, dual mount, connecting conduit, wire, junction boxes, and wire to Bungalow termination at Bungalow. Constructed and maintained by City.

New sidewalk on west side, sidewalk widening/realignment to reduce skew angles of crossing track and increasing visibility. Constructed and maintained by City.

10 new or upgraded ADA ramps. Constructed and maintained by City.

Regrade and pave roadway at rail crossing improving vertical curve. Constructed and maintained by City.

New pavement markings, channelization, and signing. Constructed and maintained by City.

New pedestrian fencing on east side south of mainline crossing for fall protection. Constructed and maintained by City.

Section 8 – Illustration of Proposed Warning Devices

Attach a detailed design diagram, drawing, map or other illustration showing all proposed modifications, including signals, signage, pavement markings, sidewalks, etc.

- 1. Attached EXHIBIT A: BNSF Signal crossing improvements**
- 2. Attached EXHIBIT B: Roadway, sidewalk, ADA ramps, Wayside horn system, pavement markings, signage, and track crossing surfaces.**

Section 9 – Waiver of Hearing by Respondent

Waiver of Hearing

The undersigned represents the Respondent in the petition to modify highway-rail grade crossing warning signals at the following crossing.

USDOT Crossing No. 084758W

We have investigated the conditions at the crossing. We are satisfied the conditions are the same as described by the Petitioner in this docket. We agree the warning signals should be modified and consent to a decision by the commission without a hearing.

Dated at Seattle, Washington, on the 29th day of May, 2019.

Stephen Semenick

Printed name of Respondent



Signature of Respondent's Representative

Manager of Public Projects

Title

206.625.6152

Stephen.Semenick@BNSF.com

Phone number and e-mail address

2454 Occidental Ave S, Suite 2D

Seattle, WA 98134

Mailing address

The Burlington Northern & Santa Fe Railway Company

EXHIBIT A: BNSF Signal crossing improvements

TO US CANADA BORDER

TO PA JUNCTION



REPLACE: LEDS
 CONTROL DEVICES: CONSTANT WARNING
 SALVAGE: NONE
 RED = IN YELLOW = OUT


M.P. 68.83
 DOT = 084758W
 4TH ST AND RIVERSIDE DR
 PROJECT# 70502

	INSTRUMENT HOUSE
	BELL
	METER
	CROSSING CONTROL CONNECTIONS
	BIDIRECTIONAL CROSSING CONTROL
	UNIDIRECTIONAL CROSSING CONTROL
	COUPLER OR TERMINATION
	GUARD RAIL

Warning device placement:
 Clearance to C.L. Track = Min. 12'
 Edge of Road to C.L. Foundation:
 Min. 4'3" with curb,
 Min. 8'3" without curb,
 Max. 12'
 House Clearance:
 25' Min. to Near Rail
 30' Min. to Edge of Road
 ALL LIGHTS TO BE LED

BNSF RAILWAY CO.
 LOCATION: MOUNT VERNON WA
 STREET: 4TH ST AND RIVERSIDE DR
 LS: 50
 M.P. 68.83
 DOT = 084758W
 DIVISION: NORTHWEST
 SUBDIVISION: BELLINGHAM
 NO SCALE
 DATE: 02/04/19
 FILE: 70502-StateSketch.dgn
 AMW

EXHIBIT B: Roadway, sidewalk, ADA ramps, Wayside horn system, pavement markings, signage, and track crossing surfaces.


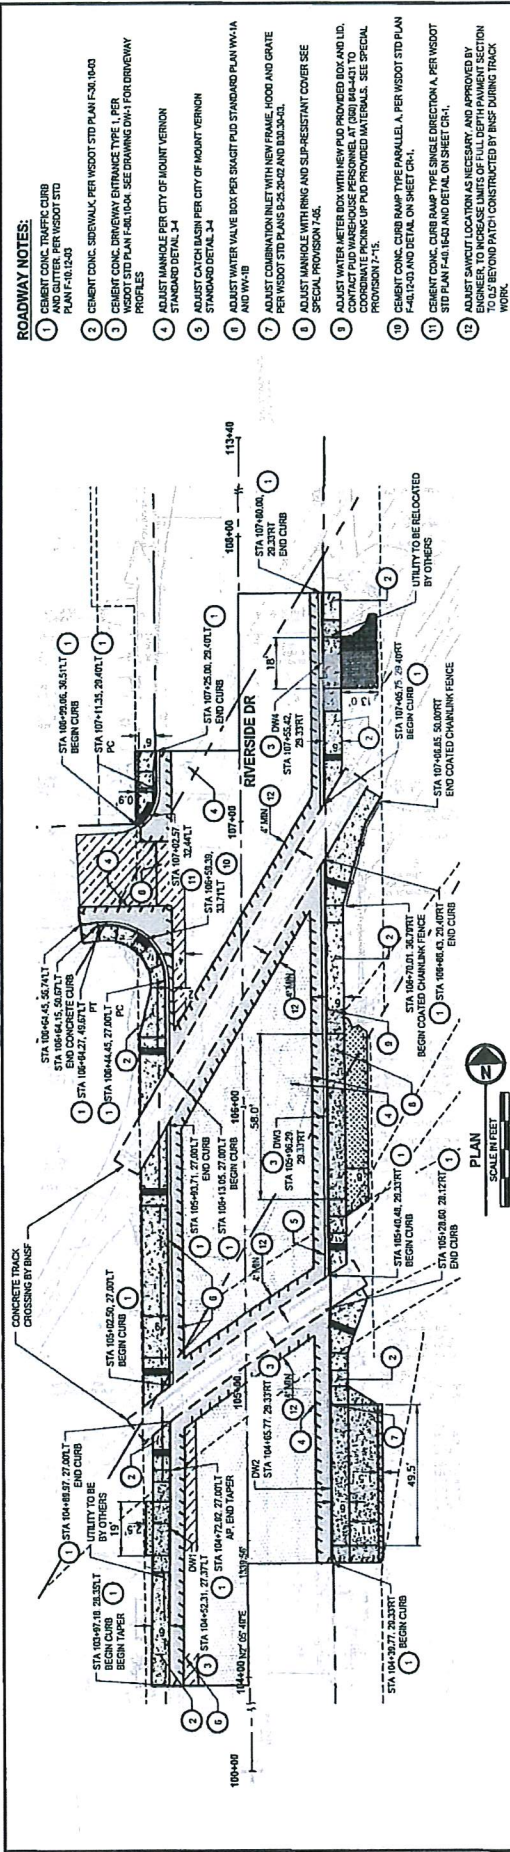


- ROADWAY NOTES:**
- 1 CEMENT CONC. DRIVEWAY CURB PER WSDOT STD PLAN F-50.19-03
 - 2 CEMENT CONC. DRIVEWAY ENTRANCE TYPE 1, PER WSDOT STD PLAN F-50.19-03
 - 3 CEMENT CONC. DRIVEWAY ENTRANCE TYPE 1, PER WSDOT STD PLAN F-50.19-03
 - 4 ADJUST MANHOLE PER CITY OF MOUNT VERNON STANDARD DETAIL 3.4
 - 5 ADJUST CATCH BASIN PER CITY OF MOUNT VERNON STANDARD DETAIL 3.4
 - 6 ADJUST WATER VALVE BOX PER SCAFF PUD STANDARD PLAN W-14-A AND W-14-B
 - 7 ADJUST COMBINATION INLET WITH NEW FRAME, HOOD AND GRATE PER WSDOT STD PLANS 9-2.30-02 AND B-30-00
 - 8 ADJUST MANHOLE WITH RING AND SUP-RESISTANT COVER SEE SPECIAL PROVISION 7.46
 - 9 ADJUST WATER METER BOX WITH NEW PUD PROVIDED BOX AND LID. CONTACT PUD WAREHOUSE PERSONNEL AT (360) 840-4471 TO COORDINATE PUD UP PUD PROVIDED MATERIALS. SEE SPECIAL PROVISION 7.16
 - 10 CEMENT CONC. CURB RAMP TYPE PARALLEL A, PER WSDOT STD PLAN F-40.17-03 AND DETAIL ON SHEET CR-1.
 - 11 CEMENT CONC. CURB RAMP TYPE SINGLE DIRECTION A, PER WSDOT STD PLAN F-40.17-03 AND DETAIL ON SHEET CR-1.
 - 12 ADJUST SAWCUT LOCATION AS NECESSARY AND APPROVED BY ENGINEER. TO INCREASE LIMITS OF FULL DEPTH PAVEMENT SECTION TO 10' BEYOND PATCH CONSTRUCTED BY BNSF DURING TRACK WORK.

- GENERAL NOTES:**
1. ALL CALLOUTS ARE TO FLOWLINE OF CURB
 2. SEE DEMOLITION PLANS FOR SAWCUT/PAVING LIMITS



- GENERAL NOTES:**
1. ALL CALLOUTS ARE TO FLOWLINE OF CURB
 2. SEE DEMOLITION PLANS FOR SAWCUT/PAVING LIMITS

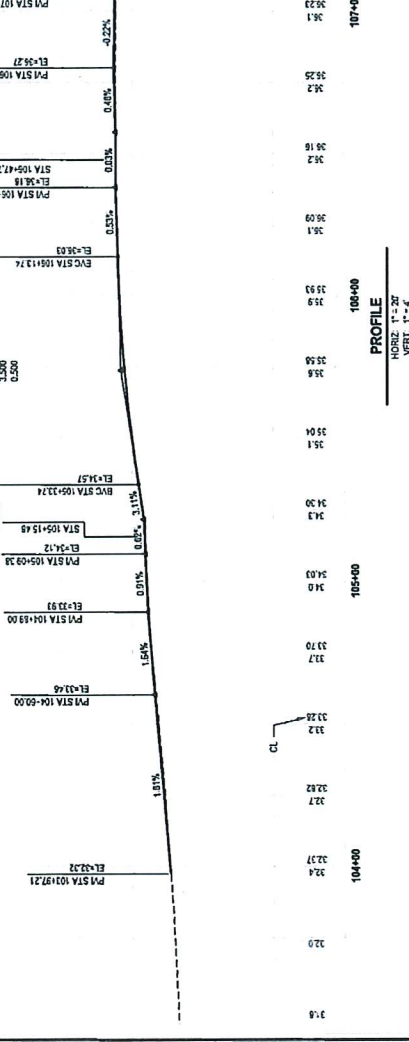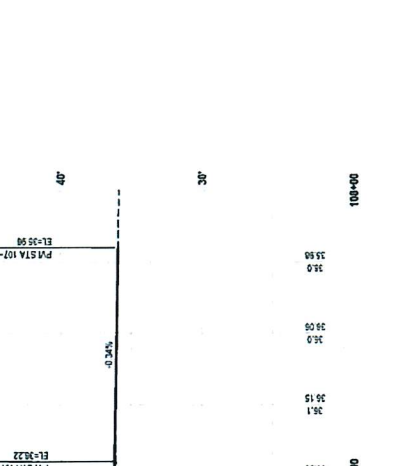

No.	Date	Revision

CHK'D	DATE	BY

PH CONSULTING LLC
Balanced Transportation Solutions
www.phtraffic.com

Parametrix
www.parametrix.com

PH CONSULTING LLC, 1000 1st Ave, Suite 100, Mount Vernon, WA 98573
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CITY OF MOUNT VERNON


4TH ST N / RIVERSIDE DR
CITY OF MOUNT VERNON
BID SET
PLAN AND PROFILE

PROJECT NO. 705-2019-0115
CONTRACT NO. #11-19
DRAWING NO. R01
SHEET 7 OF 19

BASED UPON PERMITS FOR PUBLIC UTILITIES PER 100

FED AID NO. RAAL-7223 (005) 811

EXHIBIT B: Roadway, sidewalk, ADA ramps, Wayside horn system, signage, and track crossing surfaces.

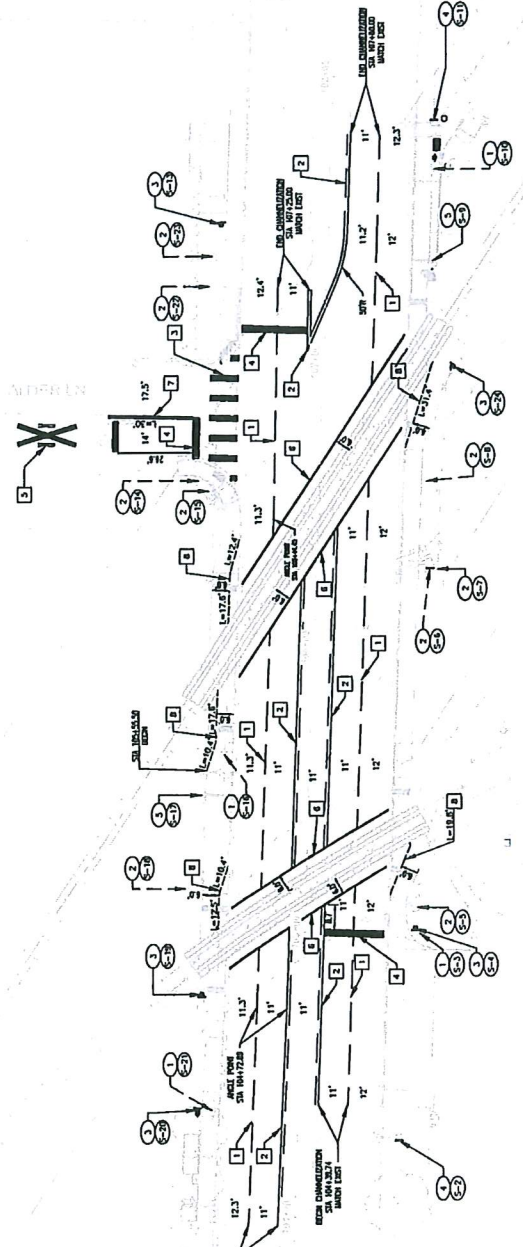

LEGEND

SYMBOL	DESCRIPTION
(Square with 'P')	PROP
(Square with 'C')	CONST.
(Circle with '1')	CHANNELIZATION CONSTRUCTION NOTE
(Circle with '2')	SIGNING CONSTRUCTION NOTE
(Circle with '3')	SIGN NOTE NUMBER
(Circle with '4')	CONSTRUCTION NOTE
(Vertical line)	EXISTING
(Vertical line with 'NEW')	NEW
(Vertical line with 'STOP BAR')	STOP BAR
(Vertical line with 'CROSSWALK')	CROSSWALK
(Vertical line with 'UTILITY POLE')	UTILITY POLE
(Vertical line with 'EREC LINE')	EREC LINE
(Vertical line with 'RIGHT-OF-WAY/PROPERTY LINE')	RIGHT-OF-WAY/PROPERTY LINE
(Vertical line with 'PAVEMENT')	PAVEMENT
(Vertical line with 'STREET LIGHT')	STREET LIGHT
(Vertical line with 'RAILROAD ARM')	RAILROAD ARM
(Vertical line with 'WAYSIDE HORN')	WAYSIDE HORN
(Vertical line with 'TURN ARROW')	TURN ARROW
(Double yellow line)	DOUBLE YELLOW CENTERLINE (4")
(Single yellow line)	SIDE LANE (YELLOW)
(No passing line)	NO PASSING LINE (YELLOW - 4")
(Median line)	MEDIAN (YELLOW - 4")

SIGNING SCHEDULE:

SIGNING	SIGN CODE	CONST. NOTE	SIGN DESCRIPTION	STA.	OFFSET	COLOR	SIZE	COMMENTS
E-1	W11.3	4	NEW SIGNAGE TO LEFT LIGHT			YELLOW/BLACK	36" X 36"	NEW SIGNAGE TO LEFT LIGHT
E-2	SPECIAL	4	NEW SIGNAGE TO RIGHT LIGHT			YELLOW/BLACK	36" X 36"	NEW SIGNAGE TO RIGHT LIGHT
E-3	W11.3	4	NEW SIGNAGE TO LEFT LIGHT			YELLOW/BLACK	36" X 36"	NEW SIGNAGE TO LEFT LIGHT
E-4	W11.3	4	NEW SIGNAGE TO RIGHT LIGHT			YELLOW/BLACK	36" X 36"	NEW SIGNAGE TO RIGHT LIGHT
E-5	W11.3	4	NEW SIGNAGE TO LEFT LIGHT			YELLOW/BLACK	36" X 36"	NEW SIGNAGE TO LEFT LIGHT
E-6	W11.3	4	NEW SIGNAGE TO RIGHT LIGHT			YELLOW/BLACK	36" X 36"	NEW SIGNAGE TO RIGHT LIGHT
E-7	W11.3	4	NEW SIGNAGE TO LEFT LIGHT			YELLOW/BLACK	36" X 36"	NEW SIGNAGE TO LEFT LIGHT
E-8	W11.3	4	NEW SIGNAGE TO RIGHT LIGHT			YELLOW/BLACK	36" X 36"	NEW SIGNAGE TO RIGHT LIGHT
E-9	W11.3	4	NEW SIGNAGE TO LEFT LIGHT			YELLOW/BLACK	36" X 36"	NEW SIGNAGE TO LEFT LIGHT
E-10	W11.3	4	NEW SIGNAGE TO RIGHT LIGHT			YELLOW/BLACK	36" X 36"	NEW SIGNAGE TO RIGHT LIGHT
E-11	W11.3	4	NEW SIGNAGE TO LEFT LIGHT			YELLOW/BLACK	36" X 36"	NEW SIGNAGE TO LEFT LIGHT
E-12	W11.3	4	NEW SIGNAGE TO RIGHT LIGHT			YELLOW/BLACK	36" X 36"	NEW SIGNAGE TO RIGHT LIGHT
E-13	W11.3	4	NEW SIGNAGE TO LEFT LIGHT			YELLOW/BLACK	36" X 36"	NEW SIGNAGE TO LEFT LIGHT
E-14	W11.3	4	NEW SIGNAGE TO RIGHT LIGHT			YELLOW/BLACK	36" X 36"	NEW SIGNAGE TO RIGHT LIGHT
E-15	W11.3	4	NEW SIGNAGE TO LEFT LIGHT			YELLOW/BLACK	36" X 36"	NEW SIGNAGE TO LEFT LIGHT
E-16	W11.3	4	NEW SIGNAGE TO RIGHT LIGHT			YELLOW/BLACK	36" X 36"	NEW SIGNAGE TO RIGHT LIGHT
E-17	W11.3	4	NEW SIGNAGE TO LEFT LIGHT			YELLOW/BLACK	36" X 36"	NEW SIGNAGE TO LEFT LIGHT
E-18	W11.3	4	NEW SIGNAGE TO RIGHT LIGHT			YELLOW/BLACK	36" X 36"	NEW SIGNAGE TO RIGHT LIGHT
E-19	W11.3	4	NEW SIGNAGE TO LEFT LIGHT			YELLOW/BLACK	36" X 36"	NEW SIGNAGE TO LEFT LIGHT
E-20	W11.3	4	NEW SIGNAGE TO RIGHT LIGHT			YELLOW/BLACK	36" X 36"	NEW SIGNAGE TO RIGHT LIGHT
E-21	W11.3	4	NEW SIGNAGE TO LEFT LIGHT			YELLOW/BLACK	36" X 36"	NEW SIGNAGE TO LEFT LIGHT
E-22	W11.3	4	NEW SIGNAGE TO RIGHT LIGHT			YELLOW/BLACK	36" X 36"	NEW SIGNAGE TO RIGHT LIGHT
E-23	W11.3	4	NEW SIGNAGE TO LEFT LIGHT			YELLOW/BLACK	36" X 36"	NEW SIGNAGE TO LEFT LIGHT
E-24	W11.3	4	NEW SIGNAGE TO RIGHT LIGHT			YELLOW/BLACK	36" X 36"	NEW SIGNAGE TO RIGHT LIGHT
E-25	W11.3	4	NEW SIGNAGE TO LEFT LIGHT			YELLOW/BLACK	36" X 36"	NEW SIGNAGE TO LEFT LIGHT
E-26	W11.3	4	NEW SIGNAGE TO RIGHT LIGHT			YELLOW/BLACK	36" X 36"	NEW SIGNAGE TO RIGHT LIGHT
E-27	W11.3	4	NEW SIGNAGE TO LEFT LIGHT			YELLOW/BLACK	36" X 36"	NEW SIGNAGE TO LEFT LIGHT
E-28	W11.3	4	NEW SIGNAGE TO RIGHT LIGHT			YELLOW/BLACK	36" X 36"	NEW SIGNAGE TO RIGHT LIGHT
E-29	W11.3	4	NEW SIGNAGE TO LEFT LIGHT			YELLOW/BLACK	36" X 36"	NEW SIGNAGE TO LEFT LIGHT
E-30	W11.3	4	NEW SIGNAGE TO RIGHT LIGHT			YELLOW/BLACK	36" X 36"	NEW SIGNAGE TO RIGHT LIGHT

GENERAL NOTES:

- CONTRACTOR SHALL COORDINATE ALL WORK WITH BNSF RAILROAD.
- BNSF FLAGGER REQUIRED FOR WORK WITHIN BNSF RIGHT OF WAY.
- ENGINEER TO FIELD VERIFY ALL SIGN LOCATIONS PRIOR TO INSTALLATION.
- ALL NEW SIGNS SHALL BE INSTALLED IN ACCORDANCE WITH BNSF STANDARD PLAN M-20.10-02.
- CONTRACTOR SHALL REMOVE ALL CONFLICTING PAVEMENT MARKINGS.
- STATION AND OFFSET ARE BASED ON ALUMINUM LINK CONSTRUCTION CENTERLINE.
- PAVEMENT MARKINGS ARE MEASURED FROM CURB FACES TO CENTER OF PAINT/PLASTIC MARKINGS UNLESS OTHERWISE SPECIFIED.

CHANNELIZATION NOTES:

- BASED PAVEMENT MARKER LANE PER WOODOT STANDARD PLAN M-20.10-02.
- PAINT TWO WAY LEFT TURN CENTERLINE WITH WOODOT STANDARD PLAN M-20.10-02 AND M-20.40-03.
- PLASTIC CROSSWALK LANE, INSTALL AND MAINTAIN PER WOODOT STANDARD PLAN M-20.10-02.
- PLASTIC STOP LINE (S-7) PER WOODOT STANDARD PLAN M-20.10-02.
- WOODOT STANDARD CROSSWALK PER WOODOT STANDARD PLAN M-20.10-02.
- WOODOT STANDARD STOP LINE PER WOODOT STANDARD PLAN M-20.10-02.
- PAINT DOUBLE CENTERLINE PER WOODOT STANDARD PLAN M-20.10-02.
- PLASTIC DOTTED LANE LINE PER WOODOT STANDARD PLAN M-20.10-02. ONE FOOT GAP COLOR BLUE.

SIGNING CONSTRUCTION NOTES:

- REMOVE TRAFFIC SIGN AND POST. SALVAGE AND DELIVER TO CITY OF MOUNT VERNON PUBLIC WORKS DEPARTMENT, 1000 W. 1ST ST., MOUNT VERNON, WA 98273 PHONE: (360) 335-4294.
- PROTECT SIGN: EXISTING SIGN TO REMAIN.
- TRAFFIC SIGN: INSTALL NEW SIGN AND POST PER CITY OF MOUNT VERNON STANDARD DETAILS J-6.
- TRAFFIC SIGN: INSTALL NEW SIGN ON EXISTING LIGHT STANDARD PER WOODOT STANDARD PLAN M-20.10-04.
- TRAFFIC SIGN: BY BNSF.

PH CONSULTING LLC
Balanced Transportation Solutions
www.phtrafficon.com

City of Mount Vernon

4TH ST N / RIVERSIDE DR
CITY OF MOUNT VERNON
BID SET


CHANNELIZATION, SIGNING, & PAVEMENT MARKINGS

PROJECT NO. 15-2018-015
CONTRACT NO. 15-2018-015
DRAWING NO. CH1
SHEET 13 OF 19

FED AID NO. RAL-725 (08) \$11
DESIGNED BY PH CONSULTING LLC
PLEASE CALL BEFORE YOU DIG


No.	Date	Revision

EXHIBIT B: Roadway, sidewalk, ADA ramps, Wayside horn system, pavement markings, signage, and track crossing surfaces.

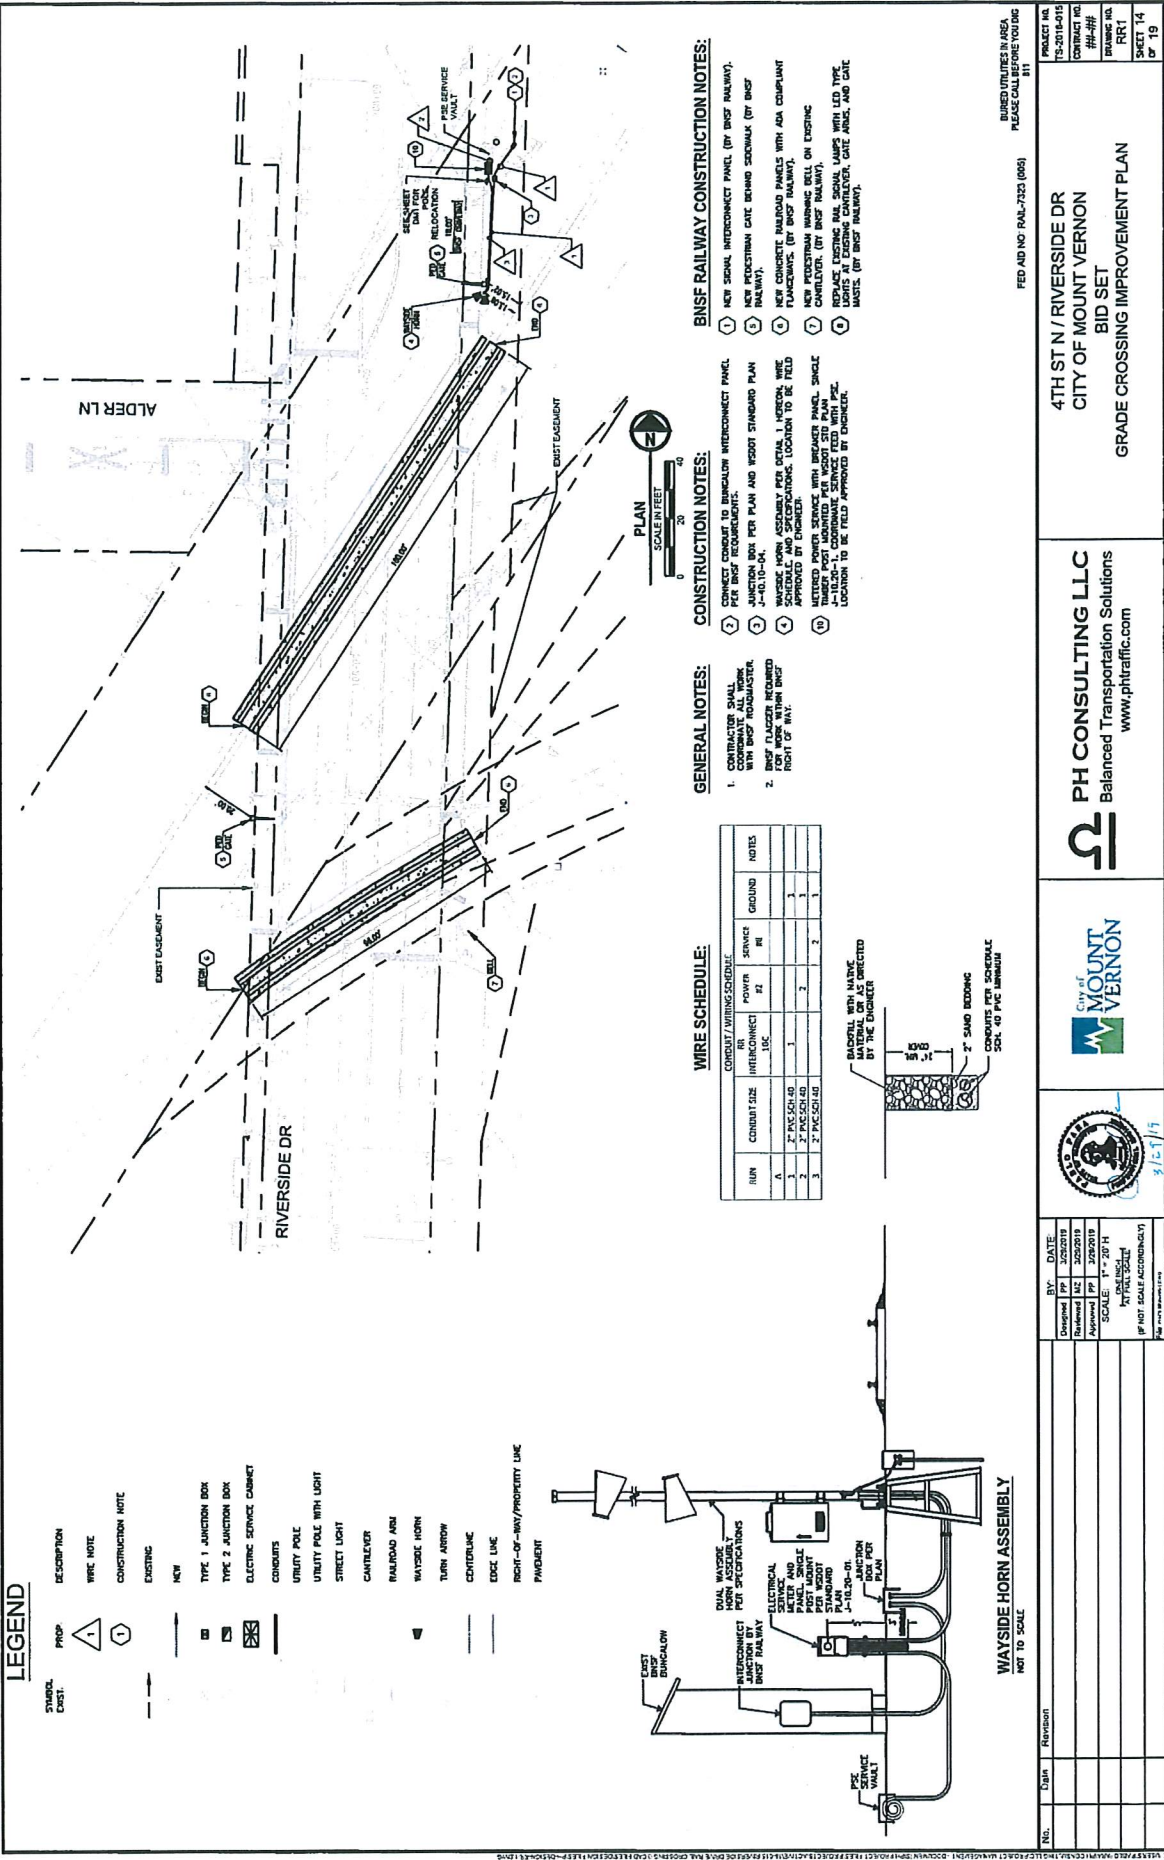

LEGEND

- | | |
|----------------------------|----------------------------|
| STANDARD
EXIST. | DESCRIPTION |
| PROPOSED | DESCRIPTION |
| WIRE NOTE | WIRE NOTE |
| CONSTRUCTION NOTE | CONSTRUCTION NOTE |
| EXISTING | EXISTING |
| NEW | NEW |
| TYPE 1 JUNCTION BOX | TYPE 1 JUNCTION BOX |
| TYPE 2 JUNCTION BOX | TYPE 2 JUNCTION BOX |
| ELECTRIC SERVICE CABINET | ELECTRIC SERVICE CABINET |
| CONDUITS | CONDUITS |
| UTILITY POLE WITH LIGHT | UTILITY POLE WITH LIGHT |
| STREET LIGHT | STREET LIGHT |
| CANTILEVER | CANTILEVER |
| RAILROAD ARM | RAILROAD ARM |
| WAYSIDE HORN | WAYSIDE HORN |
| TURN ARROW | TURN ARROW |
| CENTERLINE | CENTERLINE |
| EDGE LINE | EDGE LINE |
| RIGHT-OF-WAY/PROPERTY LINE | RIGHT-OF-WAY/PROPERTY LINE |
| PROBANT | PROBANT |

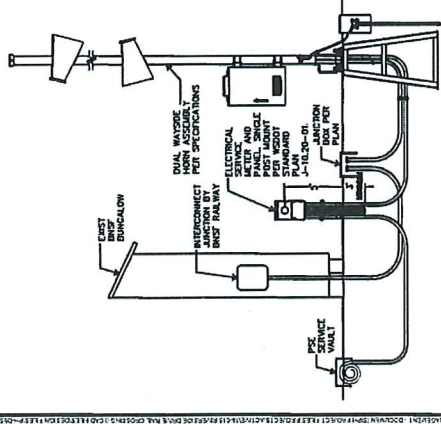

WAYSIDE HORN ASSEMBLY
NOT TO SCALE

WIRE SCHEDULE:

CONDUIT / WIRE/SCHEDULE	CONDUIT SIZE	WIRE	AMT	NOTES
INTERCONNECT	1.5"	10C	14	GROUND
2" PVC SCH 40	2"	2" PVC SCH 40	1	3
2" PVC SCH 40	2"	2" PVC SCH 40	2	1
2" PVC SCH 40	2"	2" PVC SCH 40	2	1

GENERAL NOTES:

- CONTRACTOR SHALL VERIFY ALL WORK WITH BNSF REPRESENTATIVE.
- BNSF FLAGGER REQUIRED FOR ALL WORK IN BNSF RIGHT OF WAY.
- REMOVED POWER SERVICE WITH BREAKER PANEL, SINGLE PHASE, 120/208V, 3-PHASE SERVICE FEED WITH PFE. LOCATION TO BE FIELD APPROVED BY CONTRACTOR.

CONSTRUCTION NOTES:

- CONNECT CONDUIT TO BUNGALOW INTERCONNECT PANEL.
- JUNCTION BOX PER PLAN AND WSDOT STANDARD PLAN J-10-10-04.
- BNSF FLAGGER ASSEMBLY PER SECTION 1, WSDOT SPEC SCHEDULE AND SPECIFICATIONS. LOCATION TO BE FIELD APPROVED BY CONTRACTOR.
- REMOVED POWER SERVICE WITH BREAKER PANEL, SINGLE PHASE, 120/208V, 3-PHASE SERVICE FEED WITH PFE. LOCATION TO BE FIELD APPROVED BY CONTRACTOR.

BNSF RAILWAY CONSTRUCTION NOTES:

- NEW SIGNAL INTERCONNECT PANEL (BY BNSF RAILWAY).
- NEW PROTECTION GATE BEHIND SIGNALBOX (BY BNSF RAILWAY).
- NEW CONCRETE RAILROAD PANELS WITH ADA COMPLIANT FLANKCOWS (BY BNSF RAILWAY).
- NEW POSTSTREAM MARKING BELL ON EXISTING CANTILEVER (BY BNSF RAILWAY).
- REPLACE EXISTING RAIL SIGNAL LAMPS WITH LED TYPE LAMPS AT EXISTING CANTILEVER, GATE ARMS, AND GATE POSTS (BY BNSF RAILWAY).



<p>PH CONSULTING LLC Balanced Transportation Solutions www.phtraffic.com</p>	<p>4TH ST N / RIVERSIDE DR CITY OF MOUNT VERNON BID SET GRADE CROSSING IMPROVEMENT PLAN</p>	<p>PROJECT NO. TS-2018-019 CONTRACT NO. ##-## DRAWING NO. RR1 SHEET 14 OF 19</p>
<p>City of MOUNT VERNON</p>	<p>FED AID NO. RAL-732 (069) BID NUMBER: 1452 PLACE ORDER: 145206</p>	
<p>3/15/19</p>		
<p>BY: DATE Checked: JF 3/15/19 Reviewed: MC 3/20/19 Approved: JF 3/20/19</p>		
<p>SCALE: 1" = 20' H VERTICAL IF NOT SCALE ACCORDINGLY</p>		
<p>No. Date Revision</p>		